

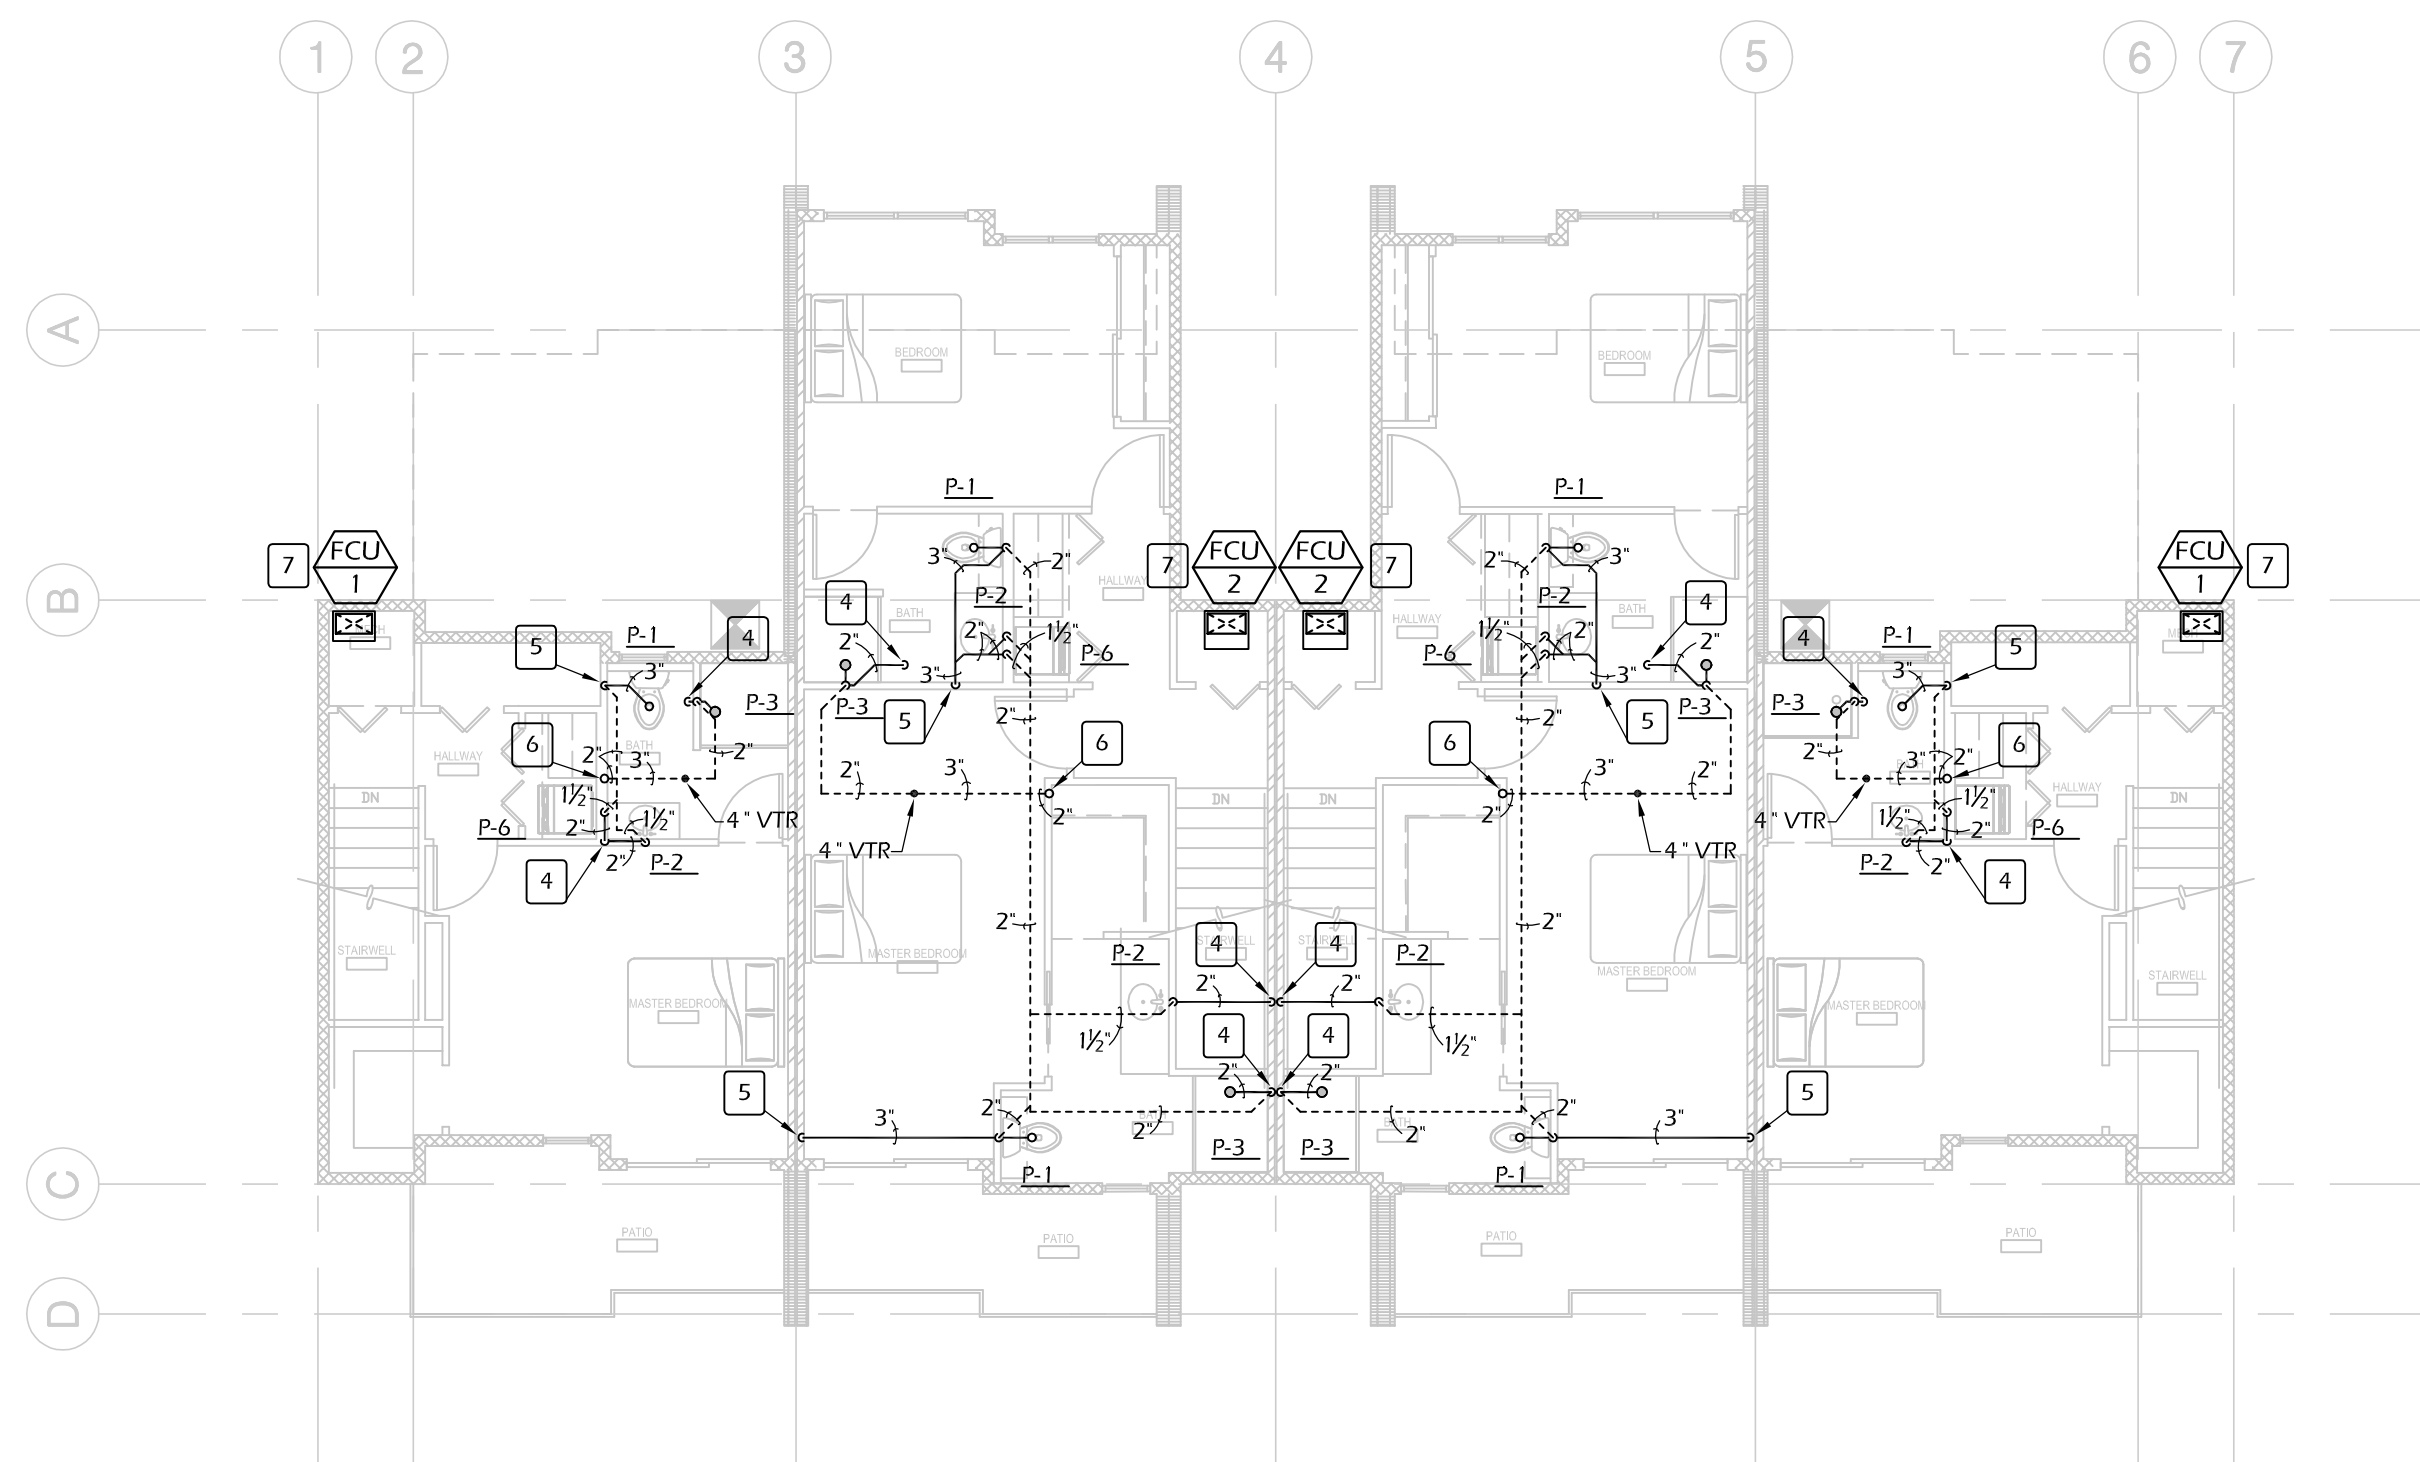


D3 WASTE PLAN - FIRST FLOOR
SCALE: 1/8" = 1'-0"

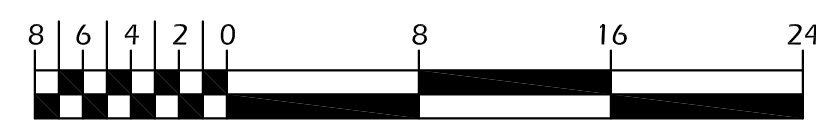

A3 WASTE PLAN - SECOND FLOOR
SCALE: 1/8" = 1'-0"

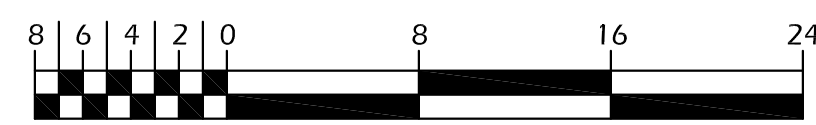

GENERAL NOTES

- COORDINATE PLUMBING FIXTURES AND PIPING WITH ALL OTHER TRADES AS REQUIRED.
- REFERENCE ARCHITECTURAL FLOOR PLANS FOR EXACT FIXTURE LOCATIONS & MOUNTING HEIGHTS.
- COORDINATE LOCATION OF ACCESS PANELS WITH GENERAL CONTRACTOR.
- WASTE PIPING SMALLER THAN 4" IS TO BE SLOPED AT 1/4" PER FOOT. ALL WASTE PIPING 4" AND LARGER IS TO BE INSTALLED AT 1/8" SLOPE PER FOOT PENDING VERIFICATION WITH LOCAL AUTHORITY HAVING JURISDICTION.

KEY NOTES

- 2" WASTE LINE FROM ABOVE.
- 3" WASTE LINE FROM ABOVE.
- 2" VENT LINE UP.
- 2" WASTE LINE DOWN.
- 3" WASTE LINE DOWN.
- 2" VENT LINE FROM BELOW.
- RUN 3/4" CONDENSATE LINE FROM FAN COIL UNIT DOWN WALL ON WARM SIDE OF INSULATION AND TERMINATE TO EXTERIOR AT 12" ABOVE GRADE.

think
ARCHITECTURE

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NEW DEVELOPMENT

THE 27 ELM
A HUNTER RENAISSANCE DEVELOPMENT

REDMOND
OREGON

REGISTERED PROFESSIONAL
ENGINEER

11.2.16

ROBERT D. TIKKER

WASTE PLAN
Sheet Title

AS NOTED
Scale

1602
Project Number

NOVEMBER 8, 2016
Date

M3.00 - WASTE PLANDWG
File Name

Revisions

M3.00

TIKKER
ENGINEERING

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